

1. THIS DRAWING IS FOR INFORMATION AND REFERENCE AS A GENERAL GUIDANCE ONLY.
2. ALL DEPOSIT FACILITIES, PLANTS & MACHINERIES, ADDITIONAL FACILITIES, SYSTEM WIDE REQUIREMENTS ETC SHALL BE VERIFIED FOR MAINTENANCE REQUIREMENT OF ROLLING STOCK AND INFRASTRUCTURE FACILITIES.
3. ALL DIMENSIONS ARE IN MM UNLESS NOTED OTHERWISE AND TO BE READ ONLY NOTED DIMENSIONS.
4. ABSOLUTE RAIL LEVEL SHALL BE DERIVED FROM APPROVED ALIGNMENT DRAWINGS.
5. STRUCTURE SYSTEM SHOWN IS INDICATIVE. ALL STRUCTURE MEMBER SIZES TO BE DETAILED BY DESIGNER AT LATER STAGE.
6. THIS DRAWINGS HAVE BEEN DEVELOPED IN CONFORMITY TO DPR,SDO, BSR&P & OTHER COAL REQUIREMENTS.
7. SYSTEM ROOM SIZES, HEIGHTS, DOOR SIZE, FLOOR HEIGHT AND CUTOUT DIMENSIONS TO BE VERIFIED BY RELEVANT DISCIPLINES OF ENGINEERING.
8. SHEETS FOR ELECTRICAL, S&T, PUMPING, DRAINAGE, SEWAGE DISPOSAL, RAIL PLANNING, HARVESTING, FIRE AND OTHER SYSTEMS SHALL BE PROVIDED AS PER SYSTEM AND MEP REQUIREMENTS.
9. ALL FINISHES ARE SUBJECT TO K-RIDE APPROVAL.
10. FM DISTANCE PROVIDED AT 4.25M METERS.
11. CRANE CAPACITY LOADERS ARE PORTABLE
12. TURBO VENT POSITIONS WILL BE FINALIZED BY IDEC.
13. DECISION IS MADE FOR 6 CARS, PROVISION FOR 9 CARS WILL BE MADE IN FUTURE.
14. ALL MATERIALS ARE AS PER BO.
15. LEVELS SHOWN ARE INDICATIVE FINAL LEVELS SHOULD BE CONFIRMED BEFORE EXECUTION OF THE WORK

INTERNAL	WALL FINISH SCHEDULE
CODE	DESCRIPTION
I1	ACRYLIC EMULSION PAINT
I5	100 MM HIGH CEMENT SKIRTING
I10	EXTERIOR EMULSION PAINT

NOTE:
ELECTRICAL ITEMS SHOWN
IN THE DWG ARE TENTATIVE

EMPLOYER :  RAIL INFRASTRUCTURE DEVELOPMENT COMPANY(KARNATAKA) LIMITED

PROJECT :		BENGALURU SUBURBAN RAILWAY PROJECT (BSRP) KRIDE SOLADEVANAHALLI DEPOT			
DRAWING TITLE :		PWAY AND EMERGENCY RERAILING SHED FLOOR PLAN			
DRAWING NO :		SDH-DP-PWY-01-ARC-DD-001			
SCALE = 1/75 AS SHOWN	SHEET NO.	DATE	REVISION	DWG	
	1 OF 4	07.06.2025	R6		
PRELIMINARY DWG(P), DEFINITIVE DWG(D), CONSTRUCTION DWG(C) AS BUILT DWG(B), SHOP DWG(S), MANUFACTURED DWG(M)					




BARSYL
we innovate
BALAJI RAILROAD
SYSTEMS (P) LIMITED

PROOF CONSULTANT (PC):ARCHITECTURAL
STRUCTURAL

SIGNATURE	
NAME	

DRAWING TITLE : PWAY AND EMERGENCY RERALING SHED
FLOOD PLAN

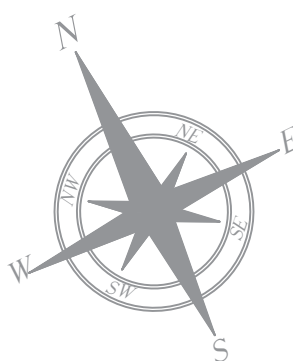

NOTES

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- ALL DIMENSIONS ARE IN MM UNLESS NOTED OTHERWISE AND TO BE READ ONLY NOT MEASURED
- ABSOLUTE RAIL LEVEL SHALL BE DERIVED FROM APPROVED ALIGNMENT DRAWINGS.
- STRUCTURE SYSTEM SHOWN IS INDICATIVE. ALL STRUCTURE MEMBER SIZES TO BE DETAILED BY DESIGNER AT LATER STAGE.
- THIS DRAWINGS HAVE BEEN DEVELOPED IN CONFORMITY TO DPR,S00, BSRP& OTHER CODAL REQUIREMENTS.
- SYSTEM ROOM SIZES, HEIGHTS, DOOR SIZE, FLOOR HEIGHT AND CUTOUT DIMENSIONS TO BE VERIFIED BY RELEVANT DISCIPLINES OF ENGINEERING.
- SHAFTS FOR ELECTRICAL, S&T, PLUMBING, DRAINAGE, SEWAGE DISPOSAL, RAIN WATER HARVESTING, FIRE AND OTHER SYSTEMS SHALL BE PROVIDED AS PER SYSTEM AND MEP REQUIREMENTS.
- ALL FINISHES ARE SUBJECT TO K-RIDE APPROVAL.
- FM DISTANCE PROVIDED AT 4.25M METERS.
- CRANE ACCESS LADDERS ARE PORTABLE
- TURBO VENT POSITIONS WILL BE FINALIZED BY IGBC
- DESIGN IS MADE FOR 6 CARS, PROVISION FOR 9 CARS WILL BE MADE IN FUTURE.
- ALL MATERIALS ARE AS PER BOQ
- LEVELS SHOWN ARE INDICATIVE FINAL LEVELS SHOULD BE CONFIRMED BEFORE EXECUTION OF THE WORK

13. TURBO VENT POSITIONS WILL BE FINALIZED BY IGBC

ABBREVIATIONS

BS	BUFFER STOP
CL	CENTER LINE
HP	HIGH POINT
RWP	RAIN WATER PIPE
RWG	RAIN WATER GUTTER

WINDOW SCHEDULE

CODE	DIMENSION	SILL	LINTEL
FL1	6000X3000MM	2100 MM	5100 MM

FLOOR FINISH SCHEDULE

CODE	DESCRIPTION
F1	HARDONITE FLOORING

INTERNAL WALL FINISH SCHEDULE

CODE	DESCRIPTION
I1	ACRYLIC EMULSION PAINT
I5	100 MM HIGH CEMENT SKIRTING
I10	EXTERIOR EMULSION PAINT

	200 MM THK BLOCKWORK
	STRUCTURAL WALL AS/STR.Dwg
	GALVALUME SHEET

NOTE:
ELECTRICAL ITEMS SHOWN
IN THE DWG ARE TENTATIVE

APPROVAL STATUS:	NONO	NONOC	NOR

EMPLOYER :

RAIL INFRASTRUCTURE DEVELOPMENT COMPANY(KARNATAKA) LIMITED

PROJECT : BENGALURU SUBURBAN RAILWAY PROJECT (BSRP)
KRIDE SOLADEVANAHALLI DEPOT


DRAWING TITLE : PWAY AND EMERGENCY RERAILING SHED
ROOF PLAN

DRAWING NO : SDH-DP-PWY-01-ARC-DD-002


SCALE	SHEET NO.	DATE	REVISION	DWG STATUS
AS SHOWN	2 OF 4	07.06.2025	R6	P

PRELIMINARY DWG(P), DEFINITIVE DWG(D),CONSTRUCTION DWG(C)
AS BUILT DWG(B), SHOP DWG(S), MANUFACTURED DWG(M)

SHEET SIZE
A1

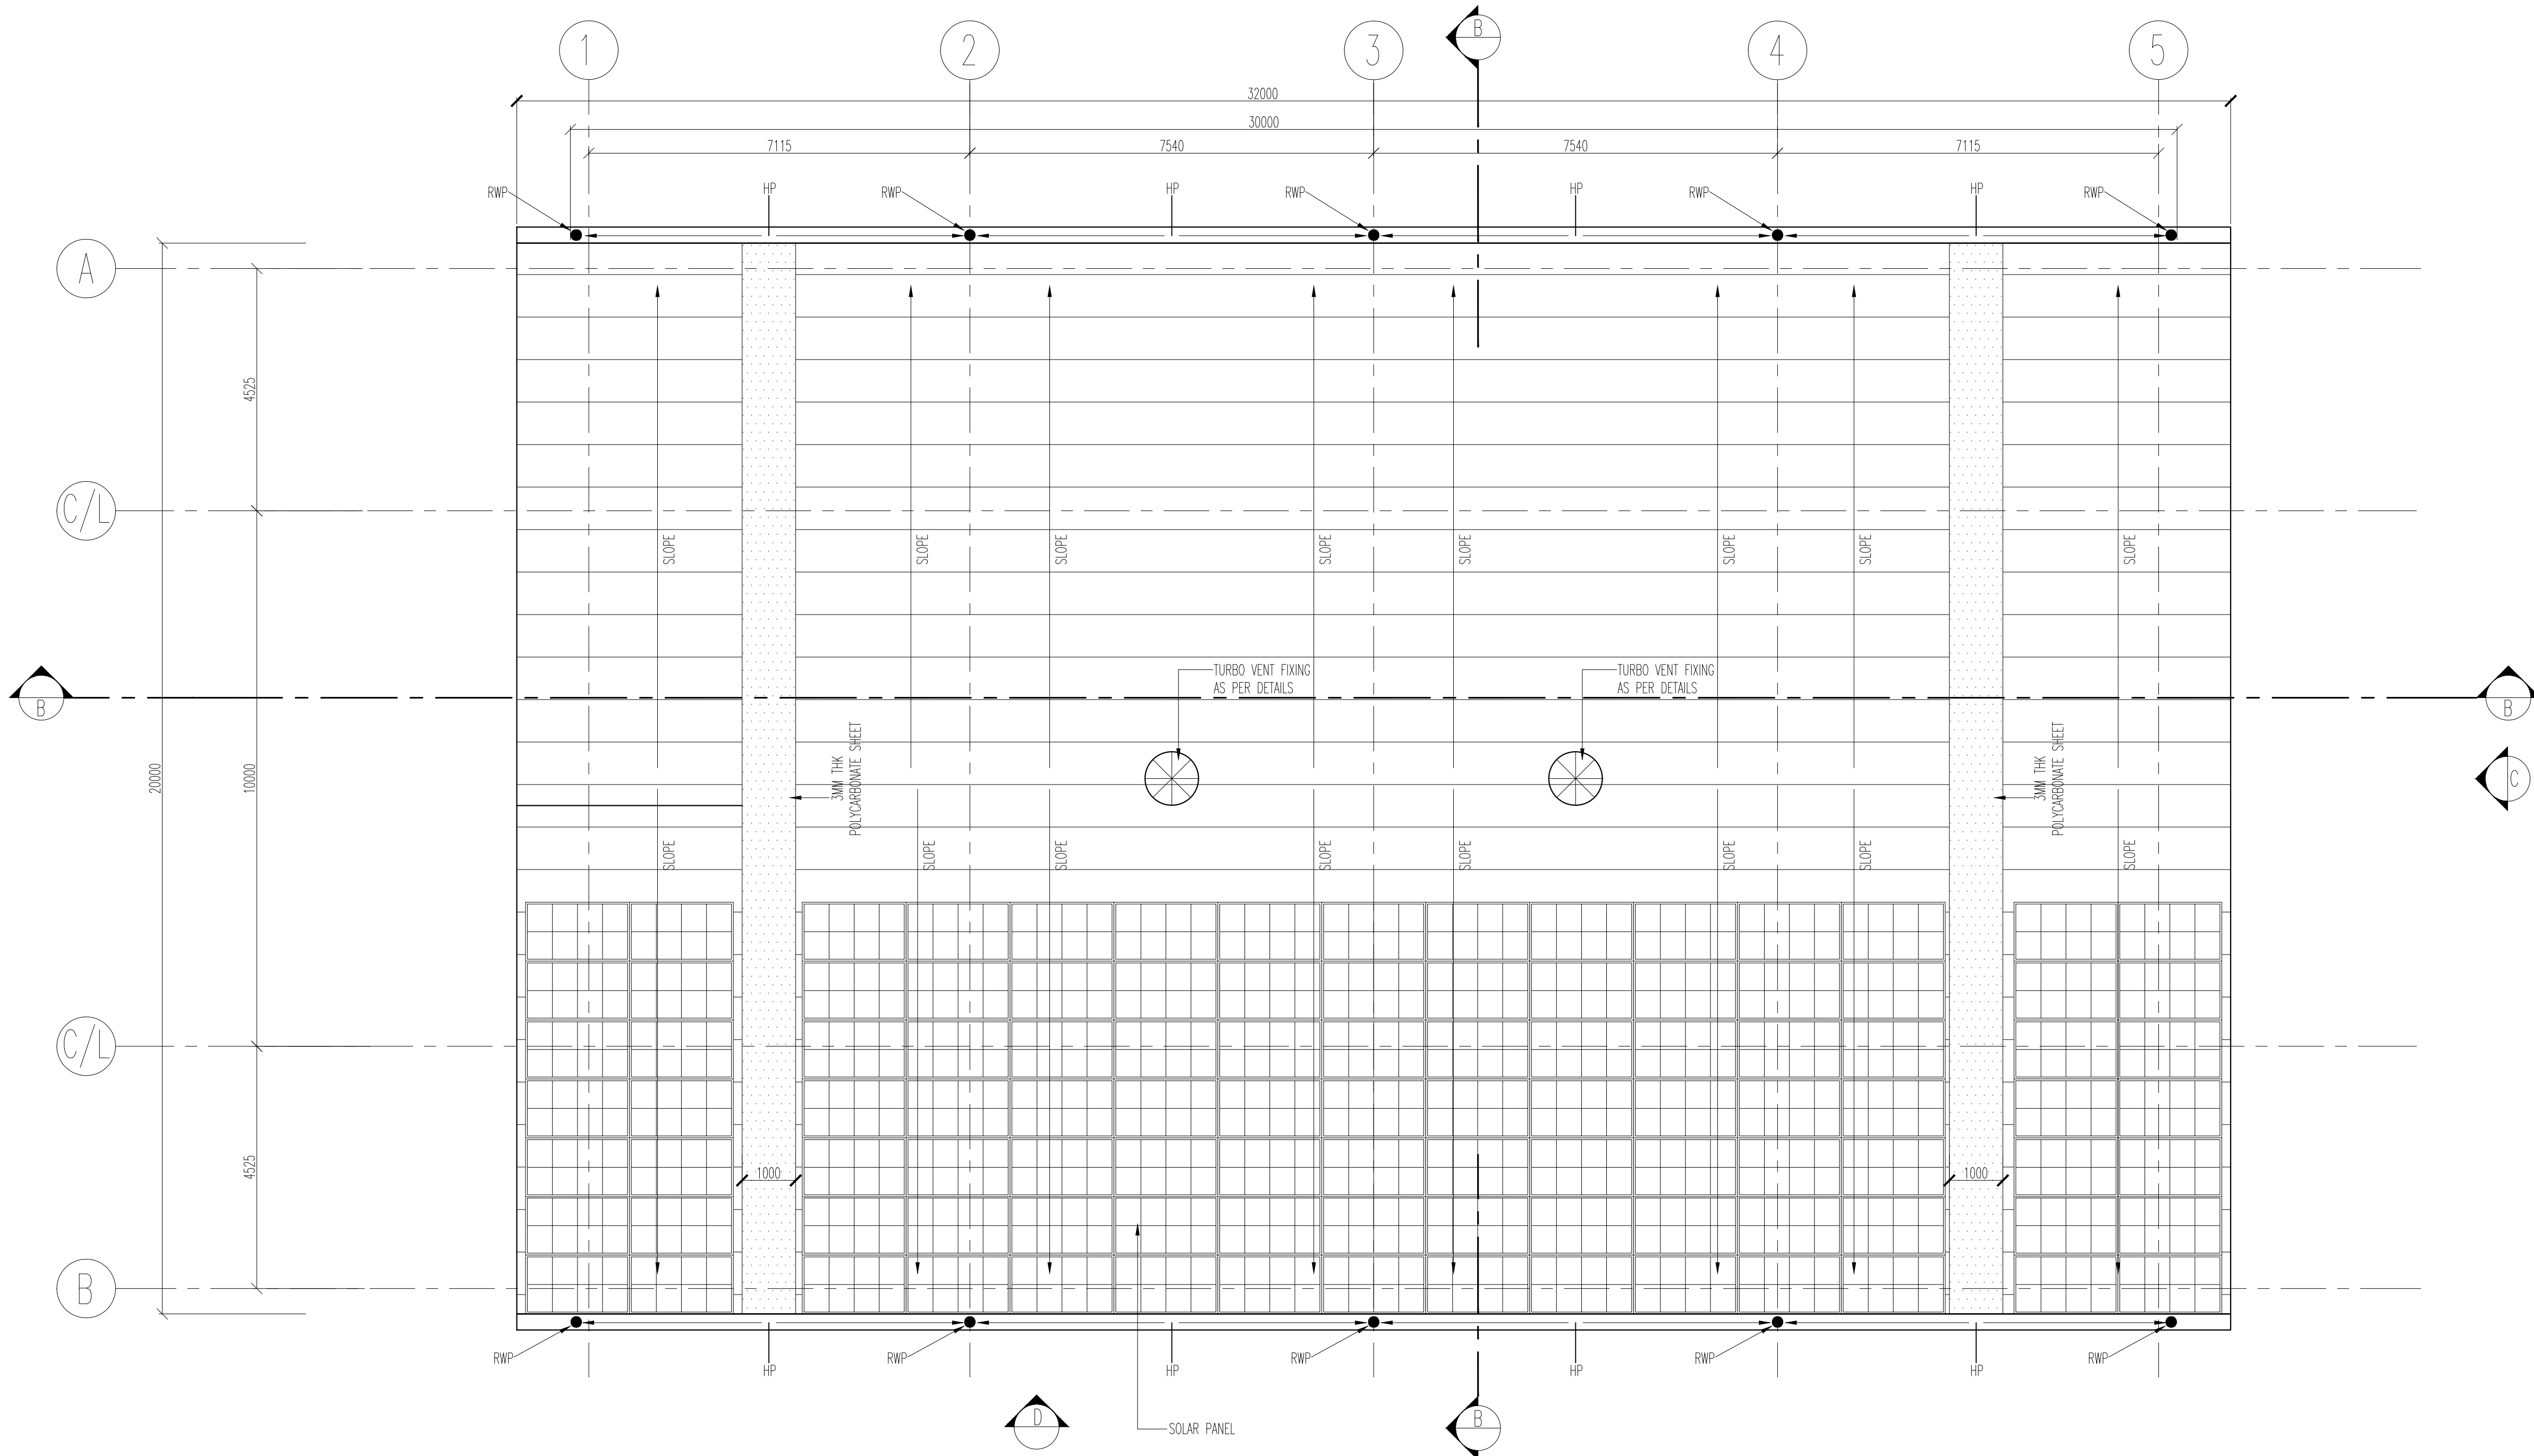

② ROOF PLAN
SCALE 1:75

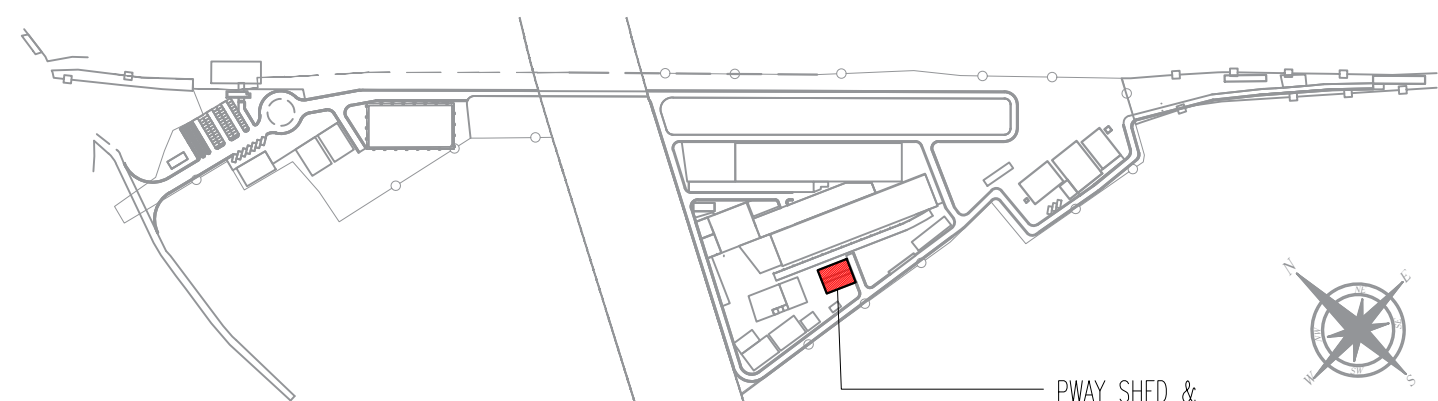

REVISIONS		
REV.NO.	DATE	DESCRIPTION
R6	07.06.2025	REVISED AS PER GC COMMENTS
R5	31.05.2025	REVISED AS PER GC COMMENTS
R4	20.05.2025	REVISED AS PER GC COMMENTS
R3	12.04.2025	REVISED AS PER GC COMMENTS
R2	03.02.2025	REVISED AS PER GC COMMENTS
R1	03.02.2025	ROOF PLAN

DDC CONSULTANT


BALAJI RAILROAD
SYSTEMS (P) LIMITED

PROOF CONSULTANT (PC):

DETAILED DESIGN CONSULTANT DDC				
PREPARED , CHECKED AND APPROVED				
DESIGNATION	SIGNATURE	DATE	PC	CONSULTANT
PREPARED BY	ARCHITECT			
CHECKED BY	DESIGN LEAD			
APPROVED BY	DGM-OPS			
IGBC CONSULTANT				

GENERAL CONSULTANT(AECOM-EGIS-WSP)			
CHECKED AND APPROVED			
DESIGNATION	SIGNATURE	DATE	COUNTER SIGN PROJECT DIRECTOR
ARCHITECTURE			
STRUCTURAL			
E&M			
S&T			
ROLLING STOCK			
MEP			
TRACK			
TRACTION			
INTER FACE			

KRIDE			
CHECKED AND APPROVED			
DESIGNATION	SIGNATURE	DATE	
ARCHITECTURE			
STRUCTURAL			
E&M			
GM DEPOT			
DGM DEPOT			

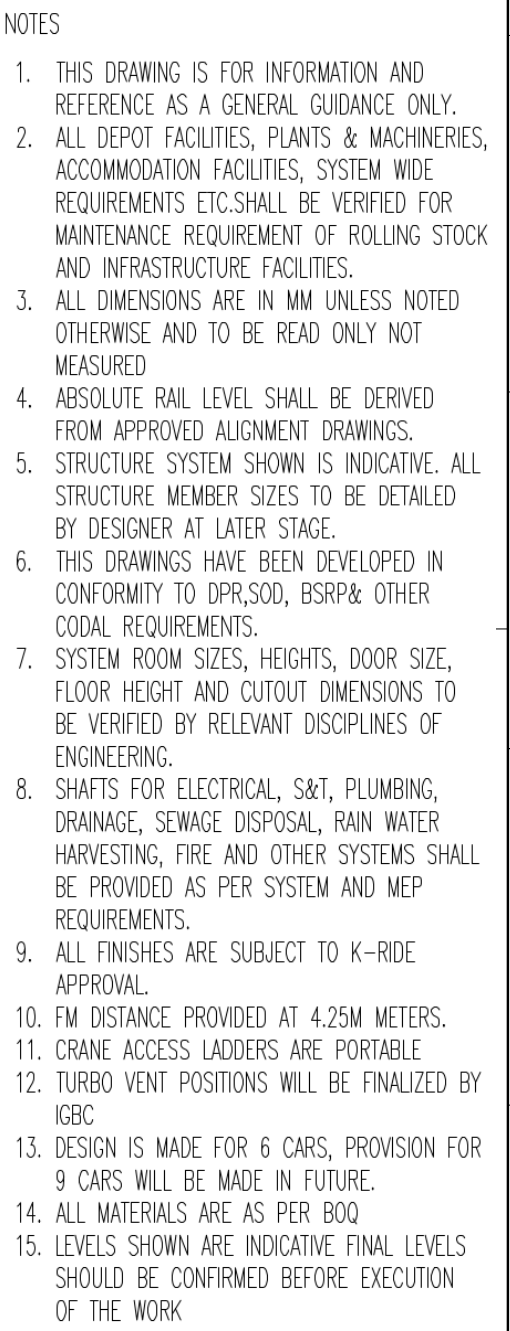




ABBREVIATIONS	
BS	BUFFER STOP
CL	CENTER LINE
HP	HIGH POINT
RWP	RAIN WATER PIPE
RWG	RAIN WATER GUTTER

WINDOW SCHEDULE			
CODE	DIMENSION	SILL	LINTEL
FL1	6000x3000MM	2100 MM	5100 MM


FLOOR FINISH SCHEDULE	
CODE	DESCRIPTION
F1	HARDONITE FLOORING

INTERNAL WALL FINISH SCHEDULE	
CODE	DESCRIPTION
I1	ACRYLIC EMULSION PAINT
I5	100 MM HIGH CEMENT SKIRTING
I10	EXTERIOR EMULSION PAINT

	200 MM THK BLOCKWORK
	STRUCTURAL WALL AS/STR.Dwg
	GALVALUME SHEET


NOTE: ELECTRICAL ITEMS SHOWN
IN THE DWG ARE TENTATIVE

APPROVAL STATUS:	NONO	NONOC	NOR

EMPLOYER :  RAIL INFRASTRUCTURE DEVELOPMENT COMPANY(KARNATAKA) LIMITED




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PROJECT :					BENGALURU SUBURBAN RAILWAY PROJECT (BSRP) KRIDE SOLADEVANAHALLI DEPOT	
DRAWING TITLE :					PWAY AND EMERGENCY RERAILING SHED SECTION AND ELEVATION	
DRAWING NO :					SDH-DP-PWY-01-ARC-DD-003	
SCALE AS SHOWN		SHEET NO.	DATE	REVISION	DWG STATUS	
		3 OF 4	07.06.2025	R6	P	
PRELIMINARY DWG(P), DEFINITIVE DWG(D), CONSTRUCTION DWG(C) AS BUILT DWG(B), SHOP DWG(S), MANUFACTURED DWG(M)					SHEET SIZE A1	

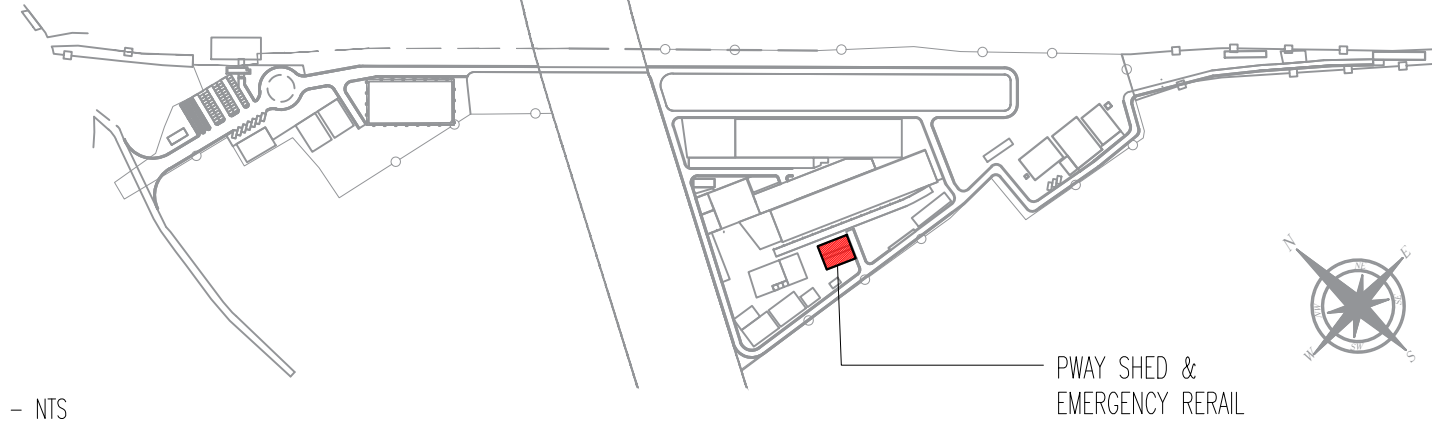


REVISIONS		
REV.NO.	DATE	DESCRIPTION
R6	07.06.2025	REVISED AS PER GC COMMENTS
R5	31.05.2025	REVISED AS PER GC COMMENTS
R4	20.05.2025	REVISED AS PER GC COMMENTS
R3	12.04.2025	REVISED AS PER GC COMMENTS
R2	03.02.2025	REVISED AS PER GC COMMENTS
R1	03.02.2025	SECTION AND ELEVATION

[illegible]

DETAILED DESIGN CONSULTANT DDC					
PREPARED , CHECKED AND APPROVED					
	DESIGNATION	SIGNATURE	DATE	PC	CONSULTANT
PREPARED BY	ARCHITECT				
CHECKED BY	DESIGN LEAD				
APPROVED BY	DGM-OPS				
GBC CONSULTANT					
				APPROVED BY	ISSUED BY

GENERAL CONSULTANT(AECOM-E)			
CHECKED AND APPROVED			
	DESIGNATION	SIGNATURE	DATE
ARCHITECTURE			
STRUCTURAL			
E&M			
S&T			
ROLLING STOCK			
MEP			
TRACK			
TRACTION			
INTER FACE			

[illegible]

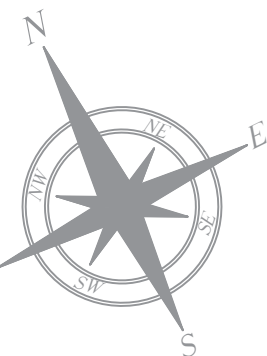

3. TURBO VENT POSITIONS WILL BE FINALIZED BY IGB

WINDOW SCHEDULE

FLOOR FINISH SCHEDULE

INTERNAL WALL FINISH SCHEDULE

15	100 MM HIGH CEMENT SKIRTING
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	800 500 500	100 000	100 000	800 500 500	100 000	100 000	800 500 500	100 000	100 000
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EMPLOYER :  RAIL INFRASTRUCTURE DEVELOPMENT COMPANY(KARNATAKA) LIMITED

PROJECT : BENGALURU SUBURBAN RAILWAY PROJECT (BSRP)BENGALURU SUBURBAN RAILWAY PROJECT (BSRP)

Variable	Mean	SD	Min	Q1	Median	Q3	Max
Age	38.5	12.5	25	30	35	40	55
Gender	0.5	0.5	0	0	0	1	1
Marital Status	0.6	0.5	0	0	0	1	1
Education	12.5	2.5	10	11	12	13	16
Income	45000	15000	20000	30000	35000	45000	70000
Health Status	0.7	0.5	0	0	0	1	1
Exercise Frequency	0.3	0.4	0	0	0	1	1
Stress Level	0.6	0.5	0	0	0	1	1
Sleep Quality	0.5	0.5	0	0	0	1	1
Dietary Habits	0.4	0.5	0	0	0	1	1
Family Size	2.5	1.5	1	2	2	3	5
Work Hours	40	10	30	35	40	45	50
Healthcare Access	0.9	0.3	0	0	0	1	1
Health Insurance	0.8	0.4	0	0	0	1	1
Chronic Conditions	0.2	0.4	0	0	0	1	1
Medication Use	0.1	0.3	0	0	0	1	1
Healthcare Costs	1000	500	0	0	0	1000	2000
Healthcare Satisfaction	0.7	0.5	0	0	0	1	1
Healthcare Access Barrier	0.3	0.5	0	0	0	1	1
Healthcare Quality	0.6	0.5	0	0	0	1	1
Healthcare Cost Barrier	0.4	0.5	0	0	0	1	1
Healthcare Access Distance	0.5	0.5	0	0	0	1	1
Healthcare Access Time	0.6	0.5	0	0	0	1	1
Healthcare Access Information	0.7	0.5	0	0	0	1	1
Healthcare Access Support	0.8	0.4	0	0	0	1	1
Healthcare Access Network	0.9	0.3	0	0	0	1	1
Healthcare Access Quality	0.7	0.5	0	0	0	1	1
Healthcare Access Cost	0.6	0.5	0	0	0	1	1
Healthcare Access Distance	0.5	0.5	0	0	0	1	1
Healthcare Access Time	0.6	0.5	0	0	0	1	1
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Healthcare Access Information	0.7	0.5	0	0	0	1	1
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Healthcare Access Information	0.7	0.5	0	0	0	1	1
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Healthcare Access Time	0.6	0.5	0	0	0	1	1
Healthcare Access Information	0.7	0.5	0	0	0	1	1
Healthcare Access Support	0.8	0.4	0	0	0	1	1
Healthcare Access Network	0.9	0.3	0	0	0	1	1
Healthcare Access Quality	0.7	0.5	0	0	0	1	1
Healthcare Access Cost	0.6	0.5	0	0	0	1	1
Healthcare Access Distance	0.5	0.5	0	0	0	1	1
Healthcare Access Time	0.6	0.5	0	0	0	1	1
Healthcare Access Information	0.7	0.5	0	0	0	1	1
Healthcare Access Support	0.8	0.4	0	0	0	1	1
Healthcare Access Network	0.9	0.3	0	0	0	1	1
Healthcare Access Quality	0.7	0.5	0	0	0	1	1
Healthcare Access Cost	0.6	0.5	0	0	0	1	1
Healthcare Access Distance	0.5	0.5	0	0	0	1	1
Healthcare Access Time	0.6	0.5	0	0	0	1	1
Healthcare Access Information	0.7	0.5	0	0	0	1	1
Healthcare Access Support	0.8	0.4	0	0	0	1	1
Healthcare Access Network	0.9	0.3	0	0	0	1	1
Healthcare Access Quality	0.7	0.5	0	0	0	1	1
Healthcare Access Cost	0.6	0.5	0	0	0	1	1
Healthcare Access Distance	0.5	0.5	0	0	0	1	1
Healthcare Access Time	0.6	0.5	0	0	0	1	1
Healthcare Access Information	0.7	0.5	0	0	0	1	1
Healthcare Access Support	0.8	0.4	0	0	0	1	1
Healthcare Access Network	0.9	0.3	0	0	0	1	1
Healthcare Access Quality	0.7	0.5	0	0	0	1	1
Healthcare Access Cost	0.6	0.5	0	0	0	1	1
Healthcare Access Distance	0.5	0.5	0	0	0	1	1
Healthcare Access Time	0.6	0.5	0	0	0	1	1
Healthcare Access Information	0.7	0.5	0	0	0	1	1
Healthcare Access Support	0.8	0.4	0	0	0	1	1
Healthcare Access Network	0.9	0.3	0	0	0	1	1
Healthcare Access Quality	0.7	0.5	0	0	0	1	1
Healthcare Access Cost	0.6	0.5	0	0	0	1	1
Healthcare Access Distance	0.5	0.5	0	0	0	1	1
Healthcare Access Time	0.6	0.5	0	0	0	1	1
Healthcare Access Information	0.7	0.5	0	0	0	1	1
Healthcare Access Support	0.8	0.4	0	0	0	1	1
Healthcare Access Network	0.9	0.3	0	0	0	1	1
Healthcare Access Quality	0.7	0.5	0	0	0	1	1
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Healthcare Access Distance	0.5	0.5	0	0	0	1	1
Healthcare Access Time	0.6	0.5	0	0	0	1	1
Healthcare Access Information	0.7	0.5	0	0	0	1	1
Healthcare Access Support	0.8	0.4	0	0	0	1	1
Healthcare Access Network	0.9	0.3	0	0	0	1	1
Healthcare Access Quality	0.7	0.5	0	0	0	1	1
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Healthcare Access Distance	0.5	0.5	0	0	0	1	1
Healthcare Access Time	0.6	0.5	0	0	0	1	1
Healthcare Access Information	0.7	0.5	0	0	0	1	1
Healthcare Access Support	0.8	0.4	0	0	0	1	1
Healthcare Access Network	0.9	0.3	0	0	0	1	1
Healthcare Access Quality	0.7	0.5	0	0			

SCALE - 1:75	SHEET NO.	DATE	REVISION	DWG STATUS
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AS SHOWN	4 OF 4	07.06.2025	R6	P
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					合：() 程：()
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PRELIMINARY DWG(P), DEFINITIVE DWG(D),CONSTRUCTION DWG(C) | SHEET SIZE

AS BUILT DWG(B) SHOP DWG(S) MANUFACTURED DWG(M) A1

DDC CONSULTANT

BARSYL
we innovate
BALAJI RAILROAD
SYSTEMS (P) LIMITED

[illegible]

PC	CONSULTANT
APPROVED BY	ISSUED BY

GENERAL CONSULTANT(AECO)			
CHECKED AND APPROVED			
	DESIGNATION	SIGNATURE	D
ARCHITECTURE			
STRUCTURAL			
&M			
&T			
ROLLING STOCK			
REP			
TRACK			
TRACTION			
WATER FACE			

[illegible][illegible]

PROJECT :		BENGALURU SUBURBAN RAILWAY PROJECT (BSRP)			
		KRIDE SOLADEYANAHALLI DEPOT			
DRAWING TITLE :		PWAY AND EMERGENCY RERAILING SHED SECTION AND ELEVATION			
DRAWING NO :		SDH-DP-WPY-01-ARC-DD-004			
SCALE	SCALE NO.	DATE	REVISION	DWG STATUS	
A5 SHOWN	4 OF 4	07.06.2025	R6	P	
PRELIMINARY DWG(P), DEFINITIVE DWG(D), CONSTRUCTION DWG(C) AS BUILT DWG(B), SHOP DWG(S), MANUFACTURED DWG(M)					SHEET SIZE A1